

COLORS & MATERIALS

3205B 3203B



PROPOSED RENDERINGS COLORS & MATERIALS EXTERIOR LIGHT FIXTURES DATE ISSUE TITLE 11/8/17 EXISTING CONDITIONS 2/6/23 SUBMIT FOR AP 6/28/23 RESUBMIT FOR AP JOB NO: 22821 DRAWN: MB CHECKED: DMK

RASTROP GROUP, I NC.
R C H I T E C T S
2345 SPRING STREET
REDWOOD CITY, CA 94063
T: 650.299.0303

B-D 5th AVE

RD. & 402

3203-3205 MIDDLEFIELD

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MIDDLEFIELD RD. & MENLO PARK, CA (

3203-3205


RETAIL / RESIDENTIAL FIRE REPAIR, REMODEL & ADDITION

PROPOSED RENDERING: REAR RESIDENCES (NORTH)

PROPOSED RENDERING: MIDDLEFIELD RD (SOUTH)

SCALE: AS NOTED

BLDG PERMIT APP NO:

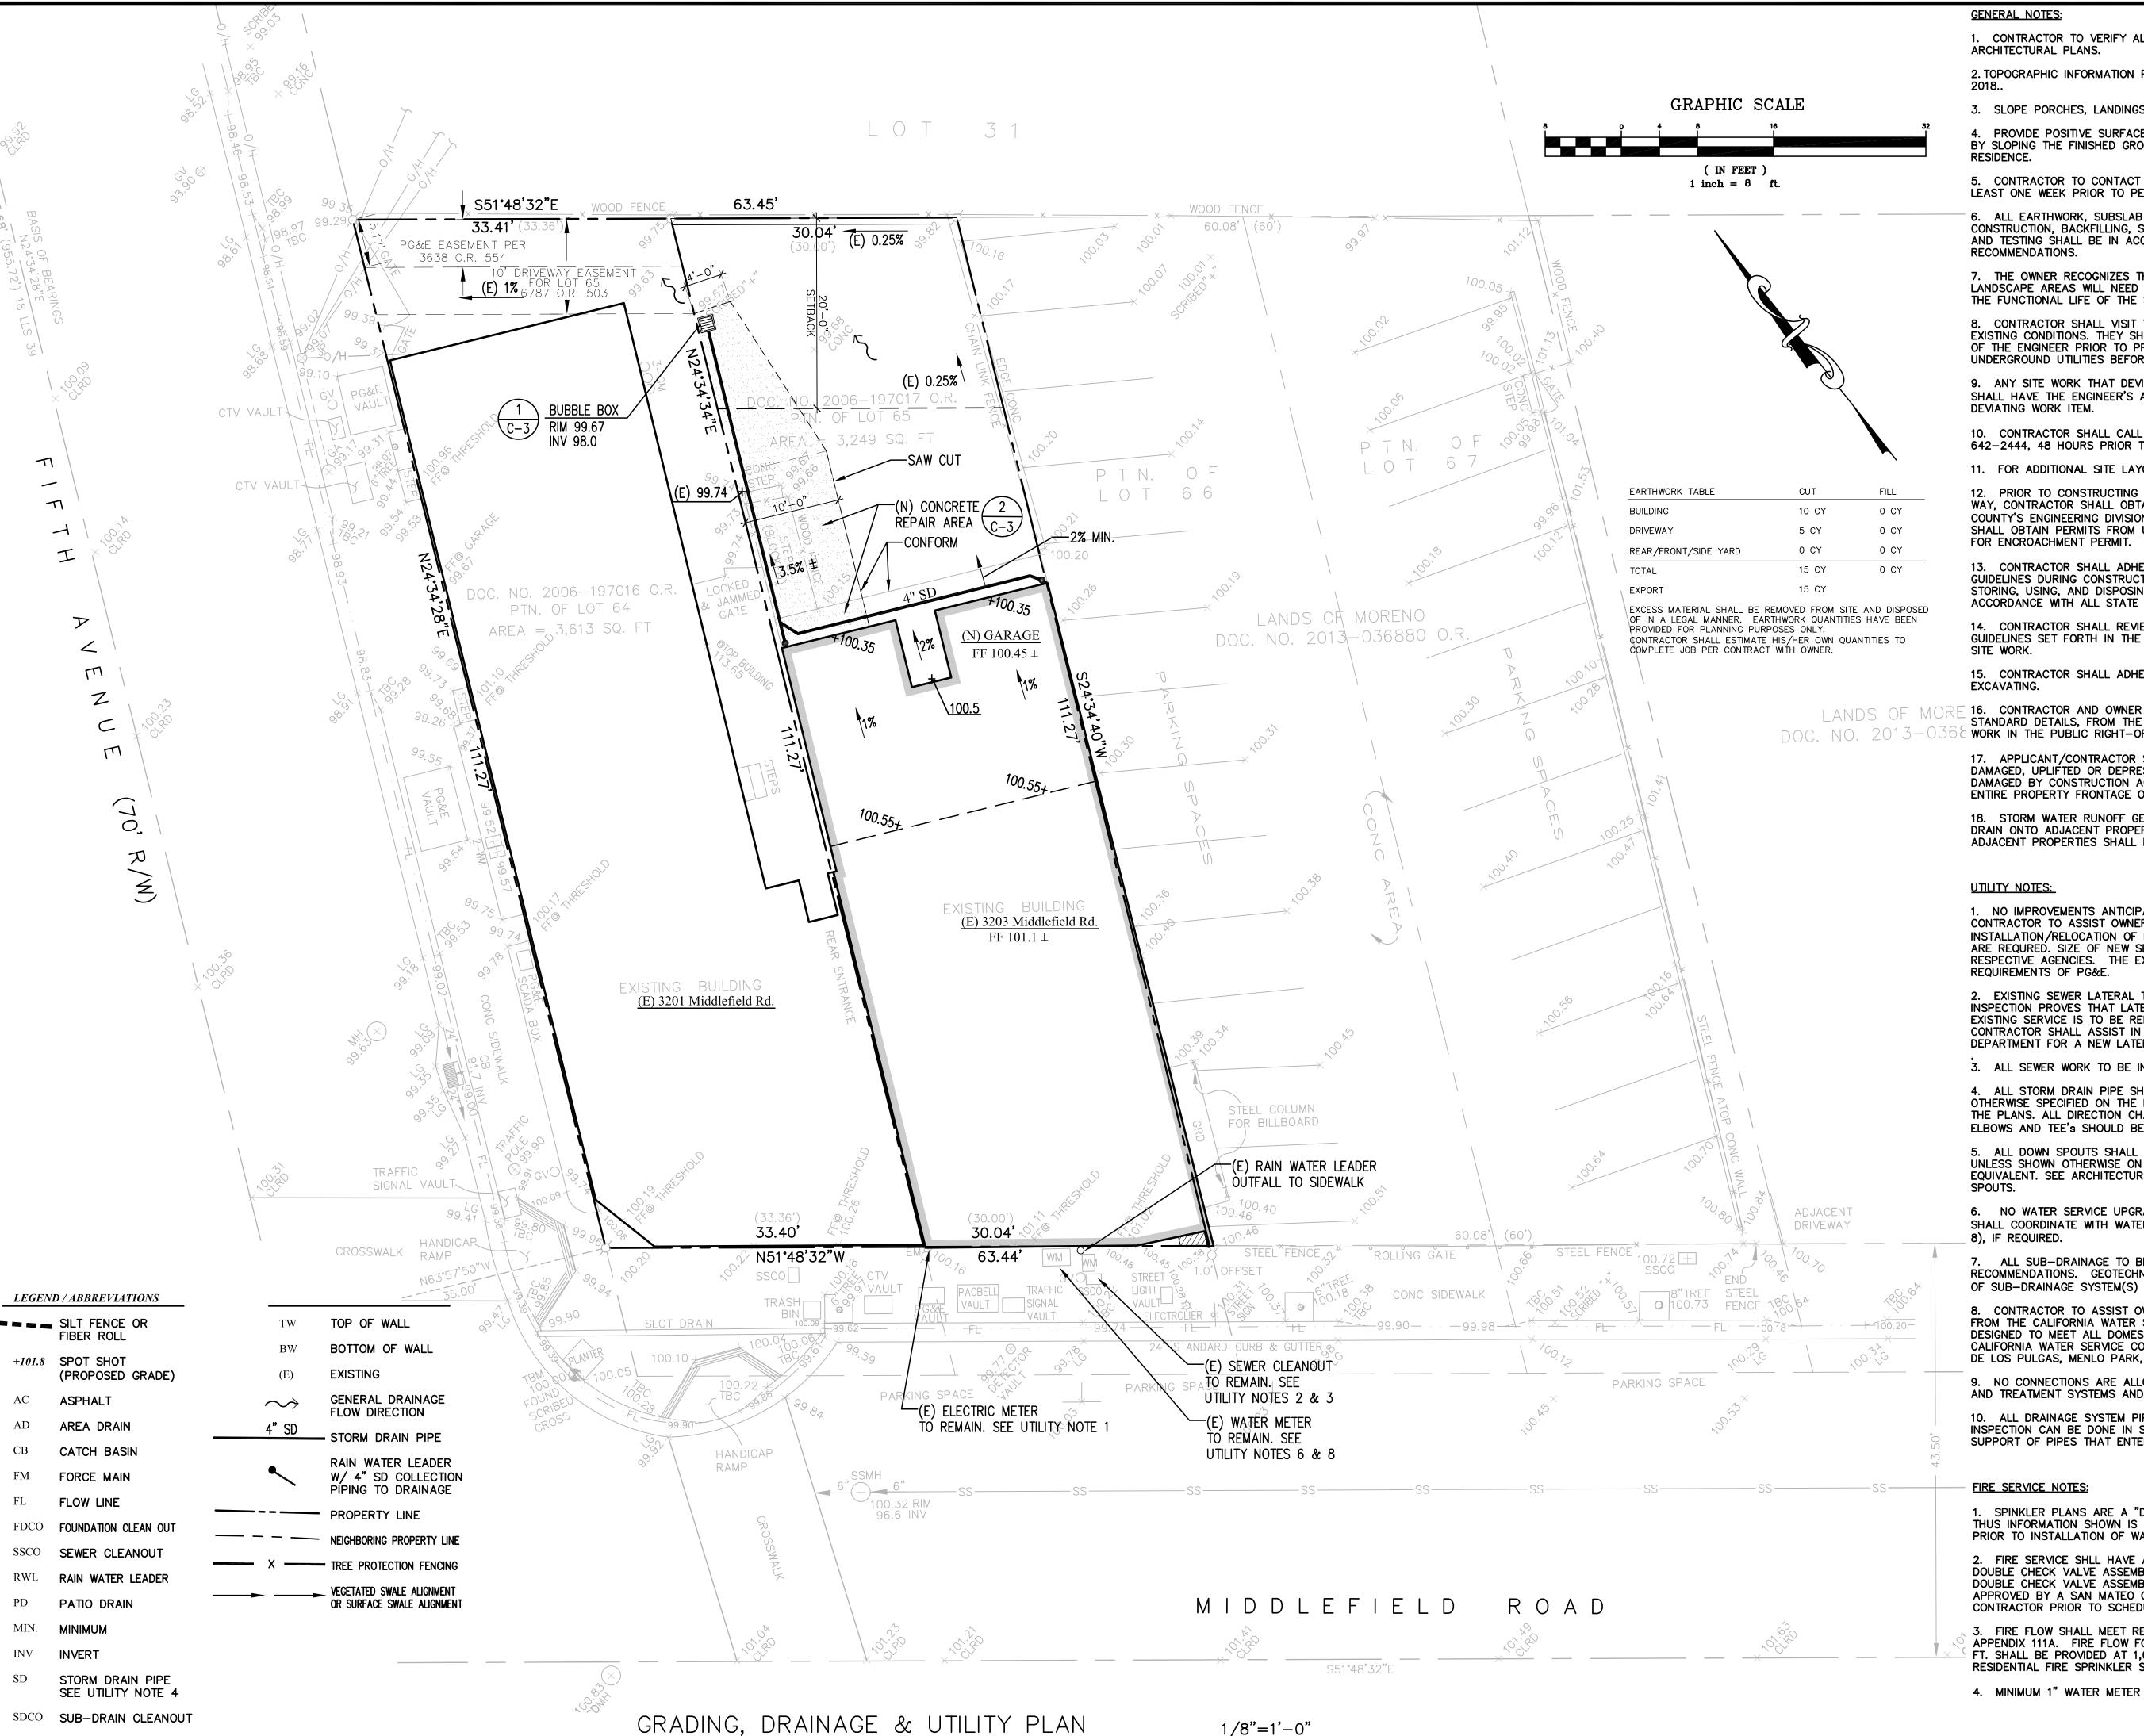

1. CONTRACTOR TO VERIFY ALL CONTROLLING DIMENSIONS & SETBACKS WITH

2. TOPOGRAPHIC INFORMATION PROVIDE BY B & H SURVEYING, INC., DATED MAY

3. SLOPE PORCHES, LANDINGS AND TERRACES 2% AWAY FROM RESIDENCE.

4. PROVIDE POSITIVE SURFACE DRAINAGE AWAY FROM THE HOUSE PERIMETER BY SLOPING THE FINISHED GROUND SURFACE AT LEAST 5% AWAY FROM

5. CONTRACTOR TO CONTACT SOILS ENGINEER TO COORDINATE INSPECTIONS AT LEAST ONE WEEK PRIOR TO PENDING INSPECTIONS.

6. ALL EARTHWORK, SUBSLAB PREPARATION, FOUNDATION AND SLAB CONSTRUCTION, BACKFILLING, SITE DRAINAGE, AND GEOTECHNICAL OBSERVATION AND TESTING SHALL BE IN ACCORDANCE WITH GEOTECHNICAL REPORT

7. THE OWNER RECOGNIZES THAT THE DRAINAGE FACILITIES AND DEPRESSED LANDSCAPE AREAS WILL NEED TO BE PERIODICALLY CLEANED OF DEBRIS DURING THE FUNCTIONAL LIFE OF THE SYSTEM.

8. CONTRACTOR SHALL VISIT THE SITE AND FAMILIARIZE THEMSELVES WITH ALL EXISTING CONDITIONS. THEY SHALL BRING ANY DISCREPANCIES TO THE ATTENTION OF THE ENGINEER PRIOR TO PROCEEDING. VERIFY THE LOCATIONS OF ALL UNDERGROUND UTILITIES BEFORE STARTING CONSTRUCTION.

9. ANY SITE WORK THAT DEVIATES FROM WHAT IS SHOWN ON THE PLANS SHALL HAVE THE ENGINEER'S APPROVAL PRIOR TO PROCEEDING WITH THE

10. CONTRACTOR SHALL CALL "UNDERGROUND SERVICE ALERT" (800) 642-2444, 48 HOURS PRIOR TO EXCAVATION.

11. FOR ADDITIONAL SITE LAYOUT INFORMATION SEE ARCHITECTURAL PLANS.

12. PRIOR TO CONSTRUCTING ANY IMPROVEMENT WITHIN THE PUBLIC RIGHT OF WAY, CONTRACTOR SHALL OBTAIN AN ENCROACHMENT PERMIT FROM THE COUNTY'S ENGINEERING DIVISION PRIOR TO STARTING ANY WORK. APPLICANT SHALL OBTAIN PERMITS FROM UTILITY COMPANIES PRIOR TO APPLYING TO CITY

13. CONTRACTOR SHALL ADHERE TO "BEST MANAGEMENT PRACTICES" (BMP's) GUIDELINES DURING CONSTRUCTION. CONTRACTOR SHALL BE RESPONSIBLE FOR STORING, USING, AND DISPOSING OF ALL HAZARDOUS MATERIALS, IN ACCORDANCE WITH ALL STATE AND LOCAL LAWS.

14. CONTRACTOR SHALL REVIEW AND UNDERSTAND GRADING AND DRAINAGE GUIDELINES SET FORTH IN THE GEOTECHNICAL REPORT PRIOR TO STARTING ANY

15. CONTRACTOR SHALL ADHERE TO CAL OSHA STANDARD WHEN GRADING AND

16. CONTRACTOR AND OWNER SHALL OBTAIN ALL NECESSARY COUNTY STANDARD DETAILS, FROM THE COUNTY, TO PERFORM ALL TRENCHING AND SITE WORK IN THE PUBLIC RIGHT-OF-WAY.

17. APPLICANT/CONTRACTOR SHALL REMOVE AND REPLACE ALL CRACKED, DAMAGED. UPLIFTED OR DEPRESSED FRONTAGE IMPROVEMENTS. EXISTING OR DAMAGED BY CONSTRUCTION ACTIVITIES, PER CITY STANDARDS ALONG THE ENTIRE PROPERTY FRONTAGE ON BELMONT AVENUE.

18. STORM WATER RUNOFF GENERATED BY THE NEW DEVELOPMENT SHALL NOT DRAIN ONTO ADJACENT PROPERTIES. THE EXISTING STORM DRAINAGE FROM THE ADJACENT PROPERTIES SHALL NOT BE BLOCKED BY THE NEW DEVELOPMENT.

1. NO IMPROVEMENTS ANTICIPATED FOR EXISTING GAS AND ELECTRIC SERVICES. CONTRACTOR TO ASSIST OWNER IN COORDINATION WITH PG&E FOR THE INSTALLATION/RELOCATION OF PHONE, TV AND ELECTRIC SERVICES, IF CHANGES ARE REQURED. SIZE OF NEW SERVICE TO BE DETERMINED BY PG&E AND RESPECTIVE AGENCIES. THE EXISTING GAS SERVICE IS TO BE ABANDON PER REQUIREMENTS OF PG&E.

2. EXISTING SEWER LATERAL TO REMAIN AND BE VIDEO INSPECTED. IF VIDEO INSPECTION PROVES THAT LATERAL IS NOT IN GOOD WORKING ORDER, THE EXISTING SERVICE IS TO BE REPLACED OR REPAIRED PER COUNTY STANDARDS. CONTRACTOR SHALL ASSIST IN PERMITTING WITH THE COUNTY SEWER DEPARTMENT FOR A NEW LATERAL AND CLEANOUT PER COUNTRY REQUIREMENTS

3. ALL SEWER WORK TO BE IN CONFORMANCE WITH COUNTY STANDARDS.

4. ALL STORM DRAIN PIPE SHALL BE PVC SDR 35, SLOPED AT 1% UNLESS OTHERWISE SPECIFIED ON THE PLANS. PIPE SHALL BE SIZED AS SPECIFIED ON THE PLANS. ALL DIRECTION CHANGES SHALL BE MADE WITH A WYE CONNECTION, ELBOWS AND TEE'S SHOULD BE AVOIDED.

5. ALL DOWN SPOUTS SHALL BE CONNECTED TO THE STORM DRAIN SYSTEM, UNLESS SHOWN OTHERWISE ON PLAN, WITH 4 M PVC SDR 35 PIPE OR EQUIVALENT. SEE ARCHITECTURAL PLANS FOR EXACT LOCATION OF THE DOWN

6. NO WATER SERVICE UPGRADES ANTICIPATED. CONTRACTOR AND OWNER SHALL COORDINATE WITH WATER SERVICE PROVIDER, FOR NEW METER (SEE NOTE

ALL SUB-DRAINAGE TO BE INSTALL PER THE GEOTECHNICAL ENGINEERS RECOMMENDATIONS. GEOTECHNICAL ENGINEER SHALL REVIEW ALL INSTALLATION

8. CONTRACTOR TO ASSIST OWNER IN THE PERMITTING OF A NEW WATER METER FROM THE CALIFORNIA WATER SERVICE. WATER LATERAL AND METER SHALL BE DESIGNED TO MEET ALL DOMESTIC AND FIRE SAFETY NEEDS. CONTACT CALIFORNIA WATER SERVICE COMPANY, BEAR GULCH DISTRICT, AT 3525 ALAMEDA DE LOS PULGAS, MENLO PARK, CA, PHONE 650-321-6800.

9. NO CONNECTIONS ARE ALLOWED, BETWEEN THE STORM WATER COLLECTION AND TREATMENT SYSTEMS AND THE SANITARY SEWER SYSTEM.

10. ALL DRAINAGE SYSTEM PIPES MUST BE INSPECTED BEFORE COVERING. INSPECTION CAN BE DONE IN STAGES AS BACKFILLING PROCEEDS, TO ALLOW FOR SUPPORT OF PIPES THAT ENTER THE SIDES OF STRUCTURES.

1. SPINKLER PLANS ARE A "DEFERRED SUBMITTAL" AT TIME OF BUILDING PERMIT, THUS INFORMATION SHOWN IS CONCEPTURAL. SEE APPROVED SPRINKLER PLANS PRIOR TO INSTALLATION OF WATER SERVICE AND METER MODIFICATIONS.

2. FIRE SERVICE SHLL HAVE A BACKFLOW PREVENTION DEVICE — USC APPROVED DOUBLE CHECK VALVE ASSEMBLY. GENERAL CONTRACTOR SHALL ENSURE THE DOUBLE CHECK VALVE ASSEMBLY FOR FIRE PROTECTION SHALL BE TESTED AND APPROVED BY A SAN MATEO COUNTY ENVIRONMENTAL HEALTH APPROVED CONTRACTOR PRIOR TO SCHEDULING WATER DEPARTMENT FINAL

3. FIRE FLOW SHALL MEET REQUIREMENTS OF THE CALIFORNIA FIRE CODE APPENDIX 111A. FIRE FLOW FOR RESIDENTIAL BUILDINGS LESS THAN 3600 SQ. FT. SHALL BE PROVIDED AT 1,000 PGM UNLESS PROTECTED BY AN AUTOMATIC RESIDENTIAL FIRE SPRINKLER SYSTEM, THEN IT MAY BE REDUCED TO 50%.

4. MINIMUM 1" WATER METER IS REQUIRED.

AND ASSOCIATES. IJC

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GRADING. DRAINAGE & UTILITY

CONTENTS:


DATE 02/03/23

SCALE **AS NOTEI**

DRAWN **J.G.** CHECKED C.B.

JOB No. 2022815

SHEET NO.

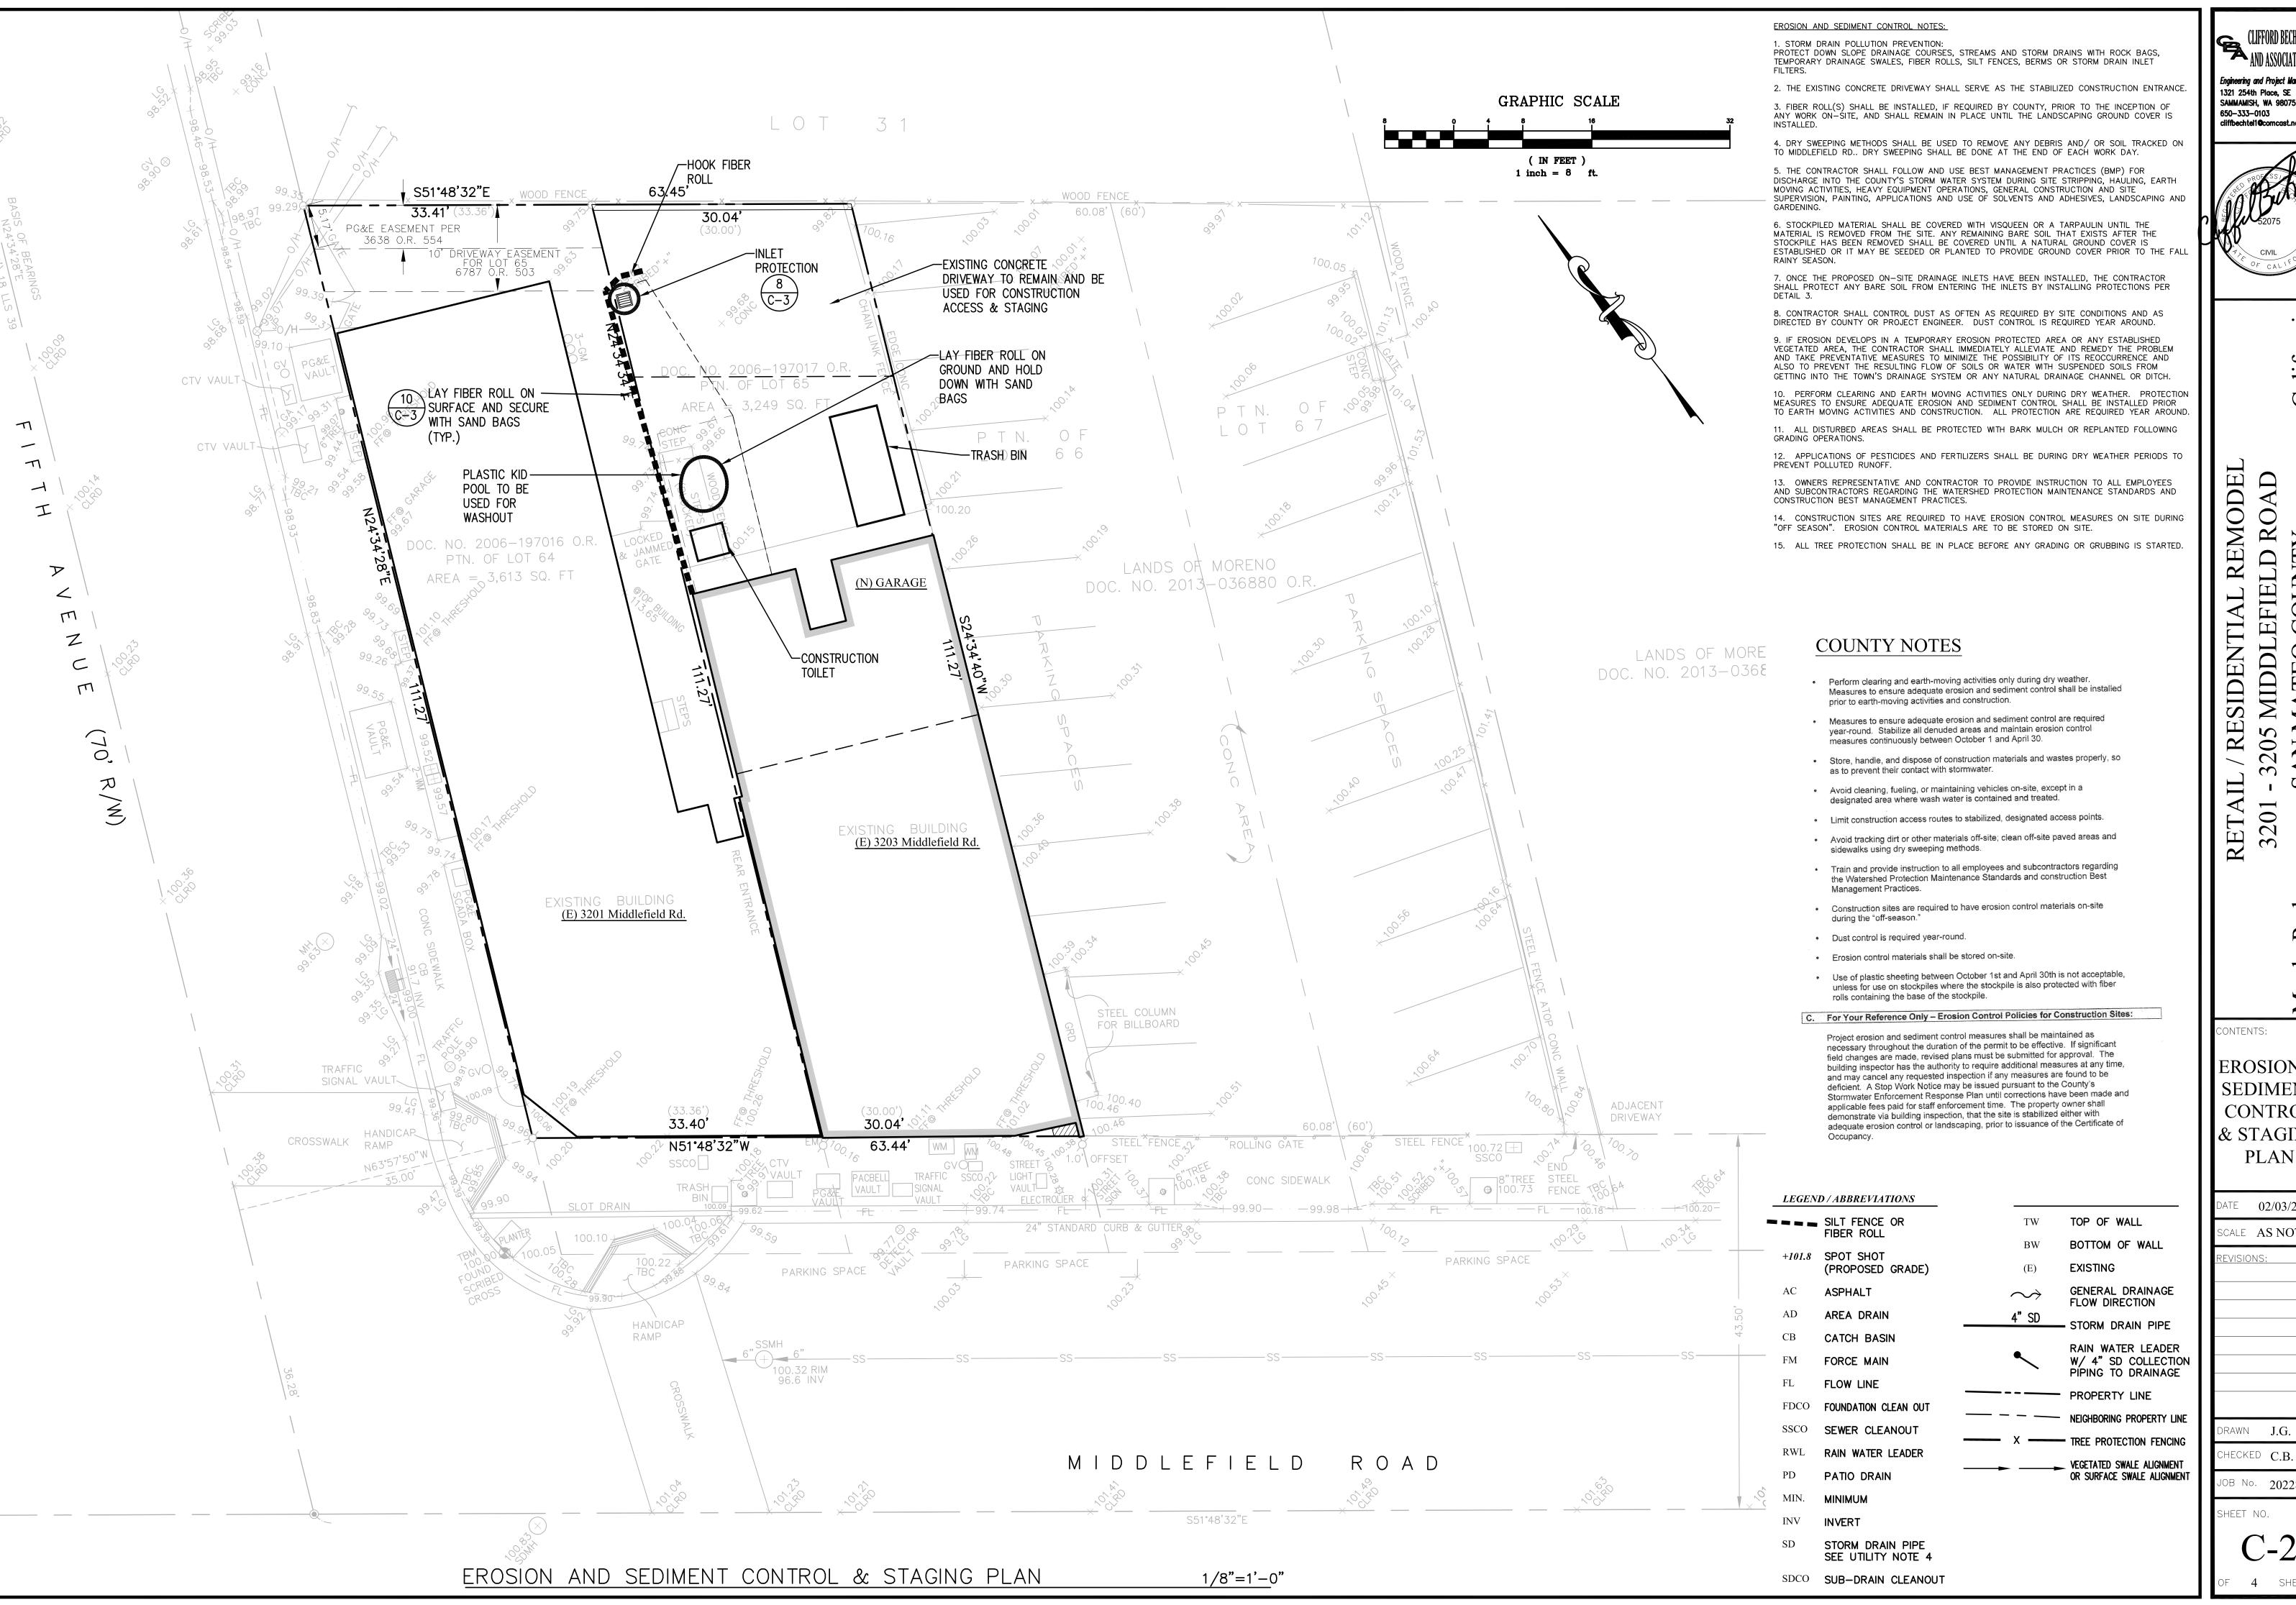

and associates,

Engineering and Project Manageme 1321 254th Place, SE SAMMAMISH, WA 98075 650-333-0103 cliffbechtel1@comcast.net

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EROSION & SEDIMENT CONTROL & STAGING **PLAN**


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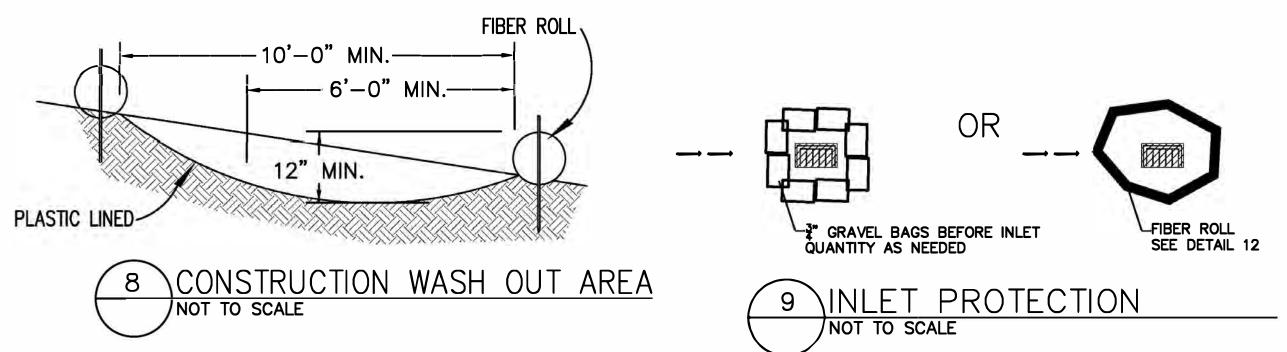
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NOT TO SCALE







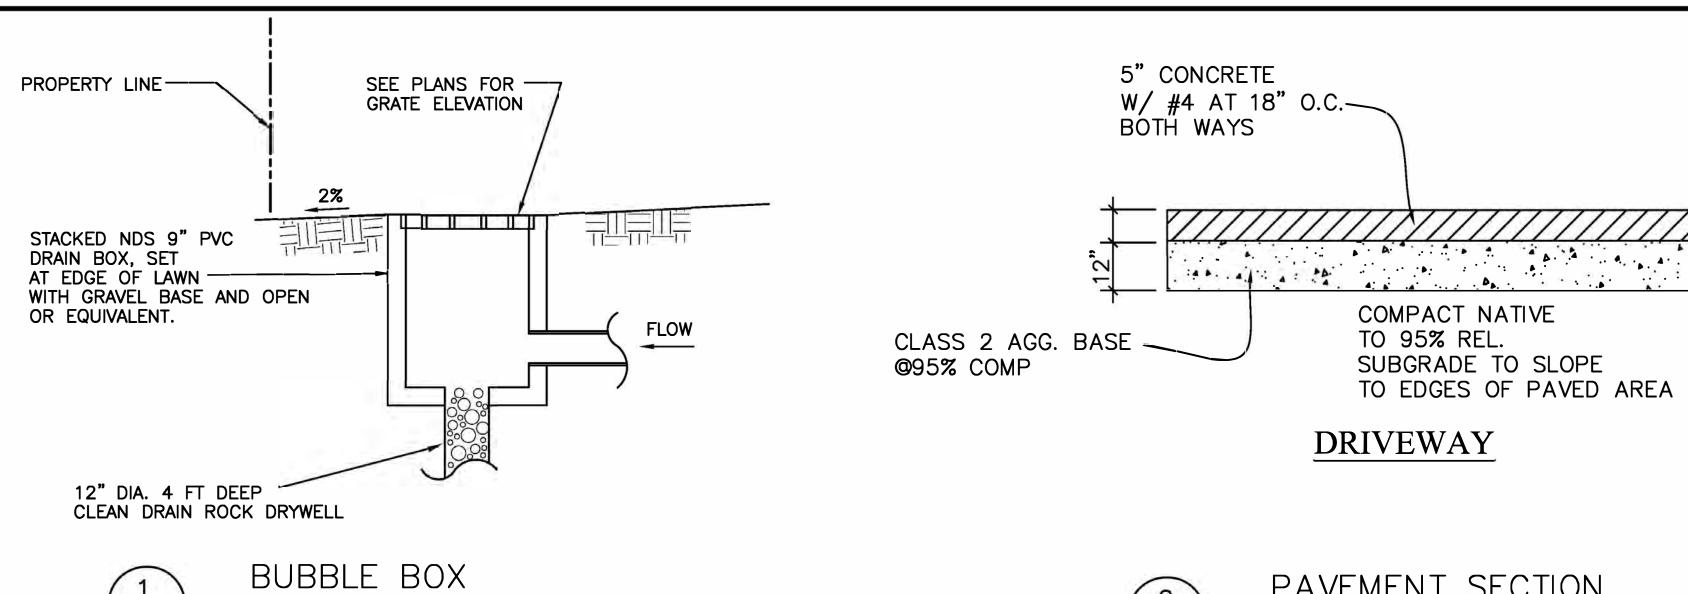

California

RETAIL / RESIDENTIAL REMODEL 3201 - 3205 MIDDLEFIELD ROAD COUNTY **MATEO**

Menlo Park

CONTENTS:

CIVIL **DETAILS**

02/03/23

SCALE AS NOTED

REVISIONS:

12" MIN.

3/4"x3/4"

ENTRENCHMENT DETAIL

IN SLOPE AREA

1. FIBER ROLL INSTALLATION REQUIRES THE PLACEMENT AND SECURE STAKING OF THE ROLL IN

A TRENCH, 3" TO 4" DEEP, DUG ON CONTOUR.

3. RUNOFF MUST NOT BE ALLOWED TO RUN UNDER OR AROUND FIBER ROLL.

2. ADJACENT ROLLS SHALL TIGHTLY ABUT.

10 FIBER ROLL


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MAX 4' SPACING

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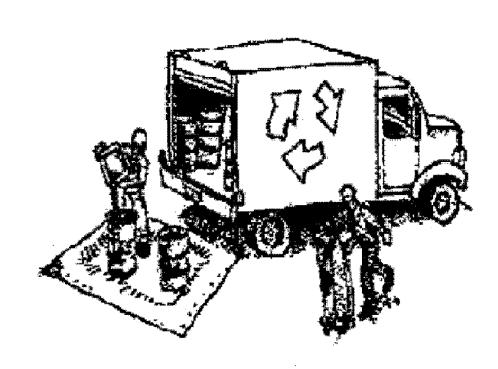


Construction Best Management Practices (BMPs)

Construction projects are required to implement the stormwater best management practices (BMP) on this page, as they apply to your project, all year long.

Clean Water. Healthy Community.

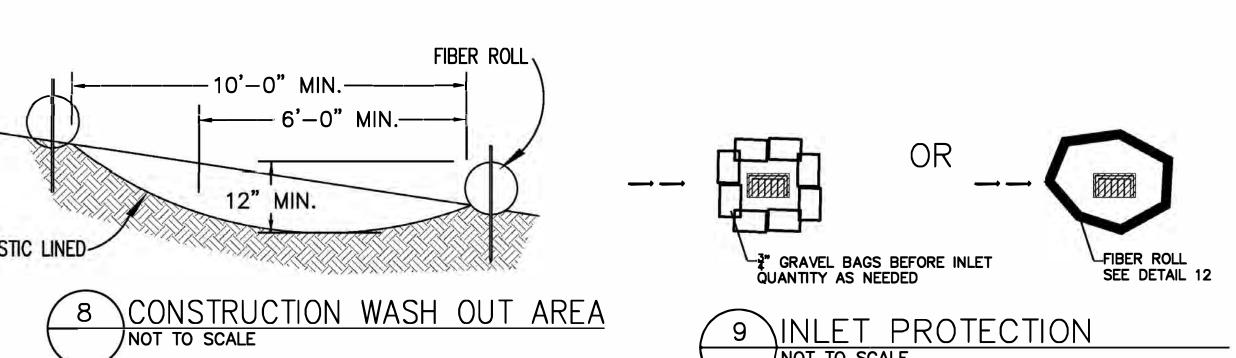Materials & Waste Management



Non-Hazardous Materials

- ☐ Berm and cover stockpiles of sand, dirt or other construction material with tarps when rain is forecast or if not actively being used within 14 days.
- ☐ Use (but don't overuse) reclaimed water for dust control.

Hazardous Materials

- ☐ Label all hazardous materials and hazardous wastes (such as pesticides, paints, thinners, solvents, fuel, oil, and antifreeze) in accordance with city, county, state and federal regulations.
- ☐ Store hazardous materials and wastes in water tight containers, store in appropriate secondary containment, and cover them at the end of every work day or during wet weather or when rain is forecast.
- ☐ Follow manufacturer's application instructions for hazardous materials and be careful not to use more than necessary. Do not apply chemicals outdoors when rain is forecast within 24 hours.
- ☐ Arrange for appropriate disposal of all hazardous wastes.


Waste Management

- ☐ Cover waste disposal containers securely with tarps at the end of every work day and during wet weather.
- ☐ Check waste disposal containers frequently for leaks and to make sure they are not overfilled. Never hose down a dumpster on the construction site.
- ☐ Clean or replace portable toilets, and inspect them frequently for leaks and spills.
- ☐ Dispose of all wastes and debris properly. Recycle materials and wastes that can be recycled (such as asphalt, concrete, aggregate base materials, wood, gyp board, pipe, etc.)
- Dispose of liquid residues from paints, thinners, solvents, glues, and cleaning fluids as hazardous waste.

Construction Entrances and Perimeter

- ☐ Establish and maintain effective perimeter controls and stabilize all construction entrances and exits to sufficiently control erosion and sediment discharges from site and tracking off site.
- ☐ Sweep or vacuum any street tracking immediately and secure sediment source to prevent further tracking. Never hose down streets to clean up tracking.

Equipment Management & **Spill Control**

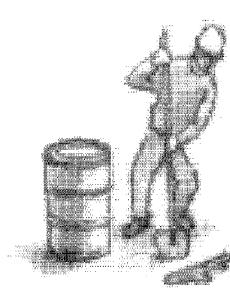


Maintenance and Parking

- Designate an area, fitted with appropriate BMPs, for vehicle and equipment parking and storage.
- Perform major maintenance, repair jobs, and vehicle and equipment washing off site.
- ☐ If refueling or vehicle maintenance must be done onsite, work in a bermed area away from storm drains and over a drip pan or drop cloths big enough to collect fluids. Recycle or dispose of fluids as hazardous waste.
- ☐ If vehicle or equipment cleaning must be done onsite. clean with water only in a bermed area that will not allow rinse water to run into gutters, streets, storm drains, or surface waters.
- Do not clean vehicle or equipment onsite using soaps, solvents, degreasers, or steam cleaning equipment.

Spill Prevention and Control

- ☐ Keep spill cleanup materials (e.g., rags, absorbents and cat litter) available at the construction site at all times
- ☐ Inspect vehicles and equipment frequently for and repair leaks promptly. Use drip pans to catch leaks until repairs are made.
- ☐ Clean up spills or leaks immediately and dispose of cleanup materials properly.
- Do not hose down surfaces where fluids have spilled. Use dry cleanup methods (absorbent materials, cat litter, and/or rags).
- ☐ Sweep up spilled dry materials immediately. Do not try to wash them away with water, or bury them.
- ☐ Clean up spills on dirt areas by digging up and properly disposing of contaminated soil.
- ☐ Report significant spills immediately. You are required by law to report all significant releases of hazardous materials, including oil. To report a spill: 1) Dial 911 or your local emergency response number, 2) Call the Governor's Office of Emergency Services Warning Center, (800) 852-7550 (24 hours).

Earthmoving

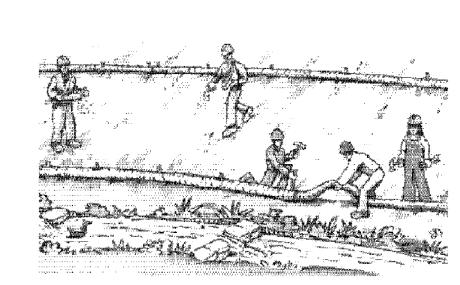


- ☐ Schedule grading and excavation work during dry weather.
- ☐ Stabilize all denuded areas, install and maintain temporary erosion controls (such as erosion control fabric or bonded fiber matrix) until vegetation is established.
- ☐ Remove existing vegetation only when absolutely necessary, and seed or plant vegetation for erosion control on slopes or where construction is not immediately planned.
- ☐ Prevent sediment from migrating offsite and protect storm drain inlets, gutters, ditches, and drainage courses by installing and maintaining appropriate BMPs, such as fiber rolls, silt fences, sediment basins. gravel bags, berms, etc.
- ☐ Keep excavated soil on site and transfer it to dump trucks on site, not in the streets.

Contaminated Soils

- ☐ If any of the following conditions are observed, test for contamination and contact the Regional Water Quality Control Board:
- Unusual soil conditions, discoloration. or odor.
- Abandoned underground tanks
- Abandoned wells
- Buried barrels, debris, or trash.

Paving/Asphalt Work

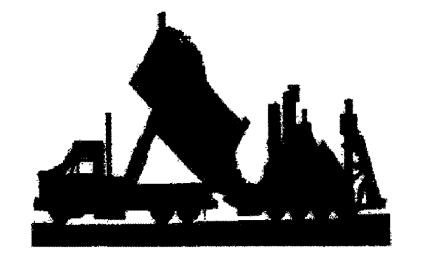


- Avoid paving and seal coating in wet weather or when rain is forecast, to prevent materials that have not cured from contacting stormwater runoff.
- □ Cover storm drain inlets and manholes when applying seal coat, tack coat, slurry seal, fog seal, etc.
- Collect and recycle or appropriately dispose of excess abrasive gravel or sand. Do NOT sweep or wash it into gutters.
- ☐ Do not use water to wash down fresh asphalt concrete pavement.

Sawcutting & Asphalt/Concrete Removal


- ☐ Protect nearby storm drain inlets when saw cutting. Use filter fabric, catch basin inlet filters, or gravel bags to keep slurry out of the storm drain system.
- ☐ Shovel, abosorb, or vacuum saw-cut slurry and dispose of all waste as soon as you are finished in one location or at the end of each work day (whichever is sooner!).
- ☐ If sawcut slurry enters a catch basin, clean it up immediately.

Concrete, Grout & Mortar Application

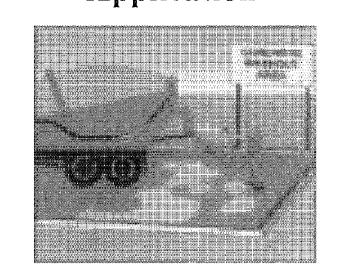


- ☐ Store concrete, grout, and mortar away from storm drains or waterways, and on pallets under cover to protect them from rain, runoff, and wind.
- ☐ Wash out concrete equipment/trucks offsite or in a designated washout area, where the water will flow into a temporary waste pit, and in a manner that will prevent leaching into the underlying soil or onto surrounding areas. Let concrete harden and dispose of as garbage.
- ☐ When washing exposed aggregate, prevent washwater from entering storm drains. Block any inlets and vacuum gutters, hose washwater onto dirt areas, or drain onto a bermed surface to be pumped and disposed of properly.

Landscaping

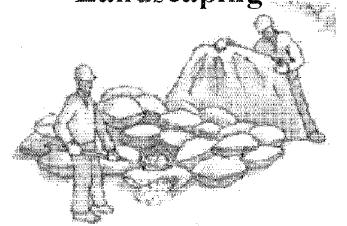


- ☐ Protect stockpiled landscaping materials from wind and rain by storing them under tarps all year-round.
- ☐ Stack bagged material on pallets and under cover.
- ☐ Discontinue application of any erodible landscape material within 2 days before a forecast rain event or during wet weather.

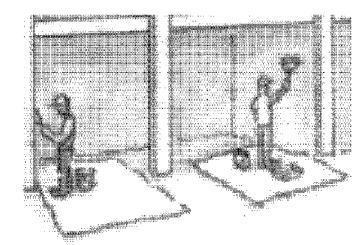

Painting Cleanup and Removal


- ☐ Never clean brushes or rinse paint containers into a street, gutter, storm drain, or stream.
- ☐ For water-based paints, paint out brushes to the extent possible, and rinse into a drain that goes to the sanitary sewer. Never pour paint down a storm drain.
- ☐ For oil-based paints, paint out brushes to the extent possible and clean with thinner or solvent in a proper container. Filter and reuse thinners and solvents. Dispose of excess liquids as hazardous waste.
- ☐ Paint chips and dust from non-hazardous dry stripping and sand blasting may be swept up or collected in plastic drop cloths and disposed of as trash.
- ☐ Chemical paint stripping residue and chips and dust from marine paints or paints containing lead, mercury, or tributyltin must be disposed of as hazardous waste. Lead based paint removal requires a statecertified contractor.

Dewatering

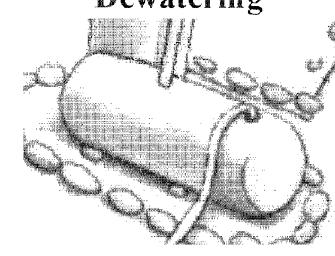

- ☐ Discharges of groundwater or captured runoff from dewatering operations must be properly managed and disposed. When possible send dewatering discharge to landscaped area or sanitary sewer. If discharging to the sanitary sewer call your local wastewater treatment plant.
- ☐ Divert run-on water from offsite away from all disturbed areas.
- ☐ When dewatering, notify and obtain approval from the local municipality before discharging water to a street gutter or storm drain. Filtration or diversion through a basin, tank, or sediment trap may be required.
- ☐ In areas of known or suspected contamination, call your local agency to determine whether the ground water must be tested. Pumped groundwater may need to be collected and hauled off-site for treatment and proper disposal.

Painting & Paint Removal

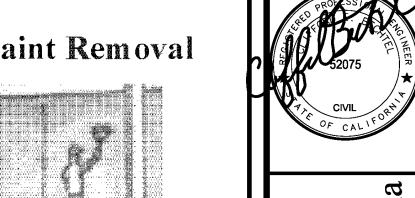

AND ASSOCIATES, TIP

REMODEL MIDDLEFIELD ROAD / RESIDENTIAL 320

CONTENTS:

CONSTRUCTION **BMP** CHECKLIST

DATE **02/03/23** SCALE AS NOTED

REVISIONS:

DRAWN J.G. CHECKED C.B.

JOB No. 202281:

SHEET NO.

Storm drain polluters may be liable for fines of up to \$10,000 per day!